
GENERAL NOTES:

- 1. PROPERTY LINES ARE BASED UPON EXISTING PLANS AND DEEDS OF RECORD AND DOES NOT REPRESENT A PROPERTY SURVEY.
- 2. EXISTING TOPOGRAPHY IS BASED UPON AN ON-GROUND TOPOGRAPHICAL SURVEY BY CONNORSTONE ENGINEERING, INC. IN OCTOBER 2014. TBM=280.03 LOCATED ON UTILITY POLE #3/3 IN LYMAN STREET. ELEVATIONS REFER TO NAVD 1988.
- 3. THE PARCEL IS LOCATED AT 1 LYMAN STREET, AS SHOWN ON ASSESSORS MAP 66, PARCEL 9,10 & 11.
- 4. A PORTION OF THE SITE IS LOCATED WITHIN A FLOOD HAZARD ZONE AS SHOWN ON FEMA F.I.R.M. 25027C0653F DATED JULY 16, 2014.
- 5. SUBSURFACE DISPOSAL SYSTEM DESIGN TO FOLLOW WITH SEPARATE APPLICATION.

CONSTRUCTION NOTES:

- 1. EXISTING UTILITY LINES SHOWN ON THIS DRAWING ARE FROM AVAILABLE INFORMATION AND ARE APPROXIMATE LOCATIONS. THE ENGINEER DOES NOT GUARANTEE THEIR ACCURACY OR THAT ALL UTILITIES AND SUBSURFACE STRUCTURES ARE SHOWN. THE CONTRACTOR SHALL VERIFY SIZE, LOCATION AND INVERT ELEVATIONS OF THE UTILITIES AND STRUCTURES, AS REQUIRED PRIOR TO THE START OF CONSTRUCTION. ANY DISCREPANCIES WITH RECORD DATA SHALL BE REPORTED TO THE ENGINEER IMMEDIATELY. THE CONTRACTOR SHALL CONTACT DIG SAFE: 1—800—344—7233 (72 HOURS BEFORE DIGGING), AND TOWN DPW FOR UTILITY LOCATIONS PRIOR TO EXCAVATION. TEST PITS SHALL BE UTILIZED FOR UTILITY CONNECTIONS.
- 2. WHERE AN EXISTING UTILITY IS FOUND TO CONFLICT WITH THE PROPOSED WORK, THE LOCATION, ELEVATION, AND SIZE OF THE UTILITY SHALL BE ACCURATELY DETERMINED WITHOUT DELAY BY THE CONTRACTOR AND THE INFORMATION FURNISHED TO THE ENGINEER FOR RESOLUTION OF THE CONFLICT.
- 3. ALL MATERIALS AND CONSTRUCTION PRACTICES SHALL BE IN CONFORMANCE WITH THE STANDARDS AND SPECIFICATIONS OF THE NORTHBOROUGH DEPARTMENT OF PUBLIC WORKS, OR THE LATEST EDITION OF THE MASSACHUSETTS HIGHWAY DEPARTMENT (MHD) CONSTRUCTION STANDARDS AND THE MHD "STANDARD SPECIFICATIONS FOR HIGHWAYS AND BRIDGES", WHICHEVER IS MORE STRINGENT.
- 4. THE WATER SYSTEM SHALL BE INSTALLED IN COMPLIANCE WITH THE TOWN OF NORTHBOROUGH DPW WATER DIVISION RULES AND REGULATIONS. CONNECTIONS SHALL BE MADE IN ACCORDANCE WITH APPLICABLE PERMITS (TO BE OBTAINED BY THE CONTRACTOR).
- 5. THE SEWER SYSTEM SHALL BE INSTALLED IN COMPLIANCE WITH THE TOWN OF NORTHBOROUGH DPW SEWER DIVISION RULES AND REGULATIONS. CONNECTIONS SHALL BE MADE IN ACCORDANCE WITH APPLICABLE PERMITS (TO BE OBTAINED BY THE CONTRACTOR). INVERTS AT THE PROPOSED BUILDING SHALL BE COORDINATED WITH THE ARCHITECTURAL DRAWINGS PRIOR TO CONSTRUCTION.
- 6. IT SHALL BE THE RESPONSIBILITY OF THE CONTRACTOR, TO KEEP ACCURATE AS—BUILT MEASUREMENTS / RECORDS OF ALL UNDERGROUND OR CONCEALED WORK.
- 7. THE LAYOUT AND INSTALLATION OF ELECTRIC, GAS, TELEPHONE AND CATV UTILITY CONNECTIONS AND SERVICES SHALL IN ACCORDANCE WITH THE REQUIREMENTS OF THE RESPECTIVE UTILITY.
- 8. THE CONTRACTOR SHALL UTILIZE ALL MEASURES AND MATERIALS NECESSARY TO ENSURE THE SAFETY OF ALL PERSONS AND PROPERTIES AT THE SITE DURING CONSTRUCTION. ALL EXCAVATIONS SHALL CONFORM TO CURRENT OSHA STANDARDS.
- 9. IT SHALL BE THE RESPONSIBILITY OF THE CONTRACTOR TO COORDINATE HIS WORK WITH THE APPROPRIATE HIGHWAY & UTILITY DEPARTMENTS. WORK WITHIN THE HIGHWAY LAYOUT SHALL CONFORM TO THE CONDITIONS OF THE PERMIT ISSUED BY MASSACHUSETTS DEPARTMENT OF TRANSPORTATION HIGHWAY DIVISION OR THE LOCAL AUTHORITY.
- 10. ALL SIGN SIZES AND MATERIAL SHALL CONFORM TO THE "MANUAL ON UNIFORM TRAFFIC DEVICES" (MUTCD) AND THE OFFICE OF TRAFFIC OPERATIONS, FEDERAL HIGHWAY ADMINISTRATION, U.S. DEPARTMENT OF TRANSPORTATION.
- 11. ALL RAMPS, CURB CUTS, SIDEWALKS, AND ACCESSIBLE SPACES SHALL COMPLY WITH THE AMERICANS WITH DISABILITIES ACT REGULATIONS AND WITH ARCHITECTURAL ACCESS BOARD REGULATIONS (521 CMR 1-47).
- 12. AREAS OUTSIDE THE LIMITS OF PROPOSED WORK DISTURBED BY THE CONTRACTOR'S OPERATIONS SHALL BE RESTORED BY THE CONTRACTOR TO THEIR ORIGINAL CONDITION AT NO EXPENSE TO THE OWNER.
- 13. JOINTS BETWEEN PROPOSED BITUMINOUS CONCRETE PAVEMENT AND EXISTING PAVEMENT TO REMAIN SHALL BE SAWCUT AND SEALED WITH HOT POURED RUBBERIZED ASPHALT SEALER.
- 14. COORDINATE ALL BUILDING DIMENSIONS, ELEVATIONS, AND UTILITY CONNECTIONS WITH THE ARCHITECTURAL DRAWINGS PRIOR TO CONSTRUCTION. ANY DISCREPANCY SHALL BE REPORTED TO THE OWNER AND ENGINEER.

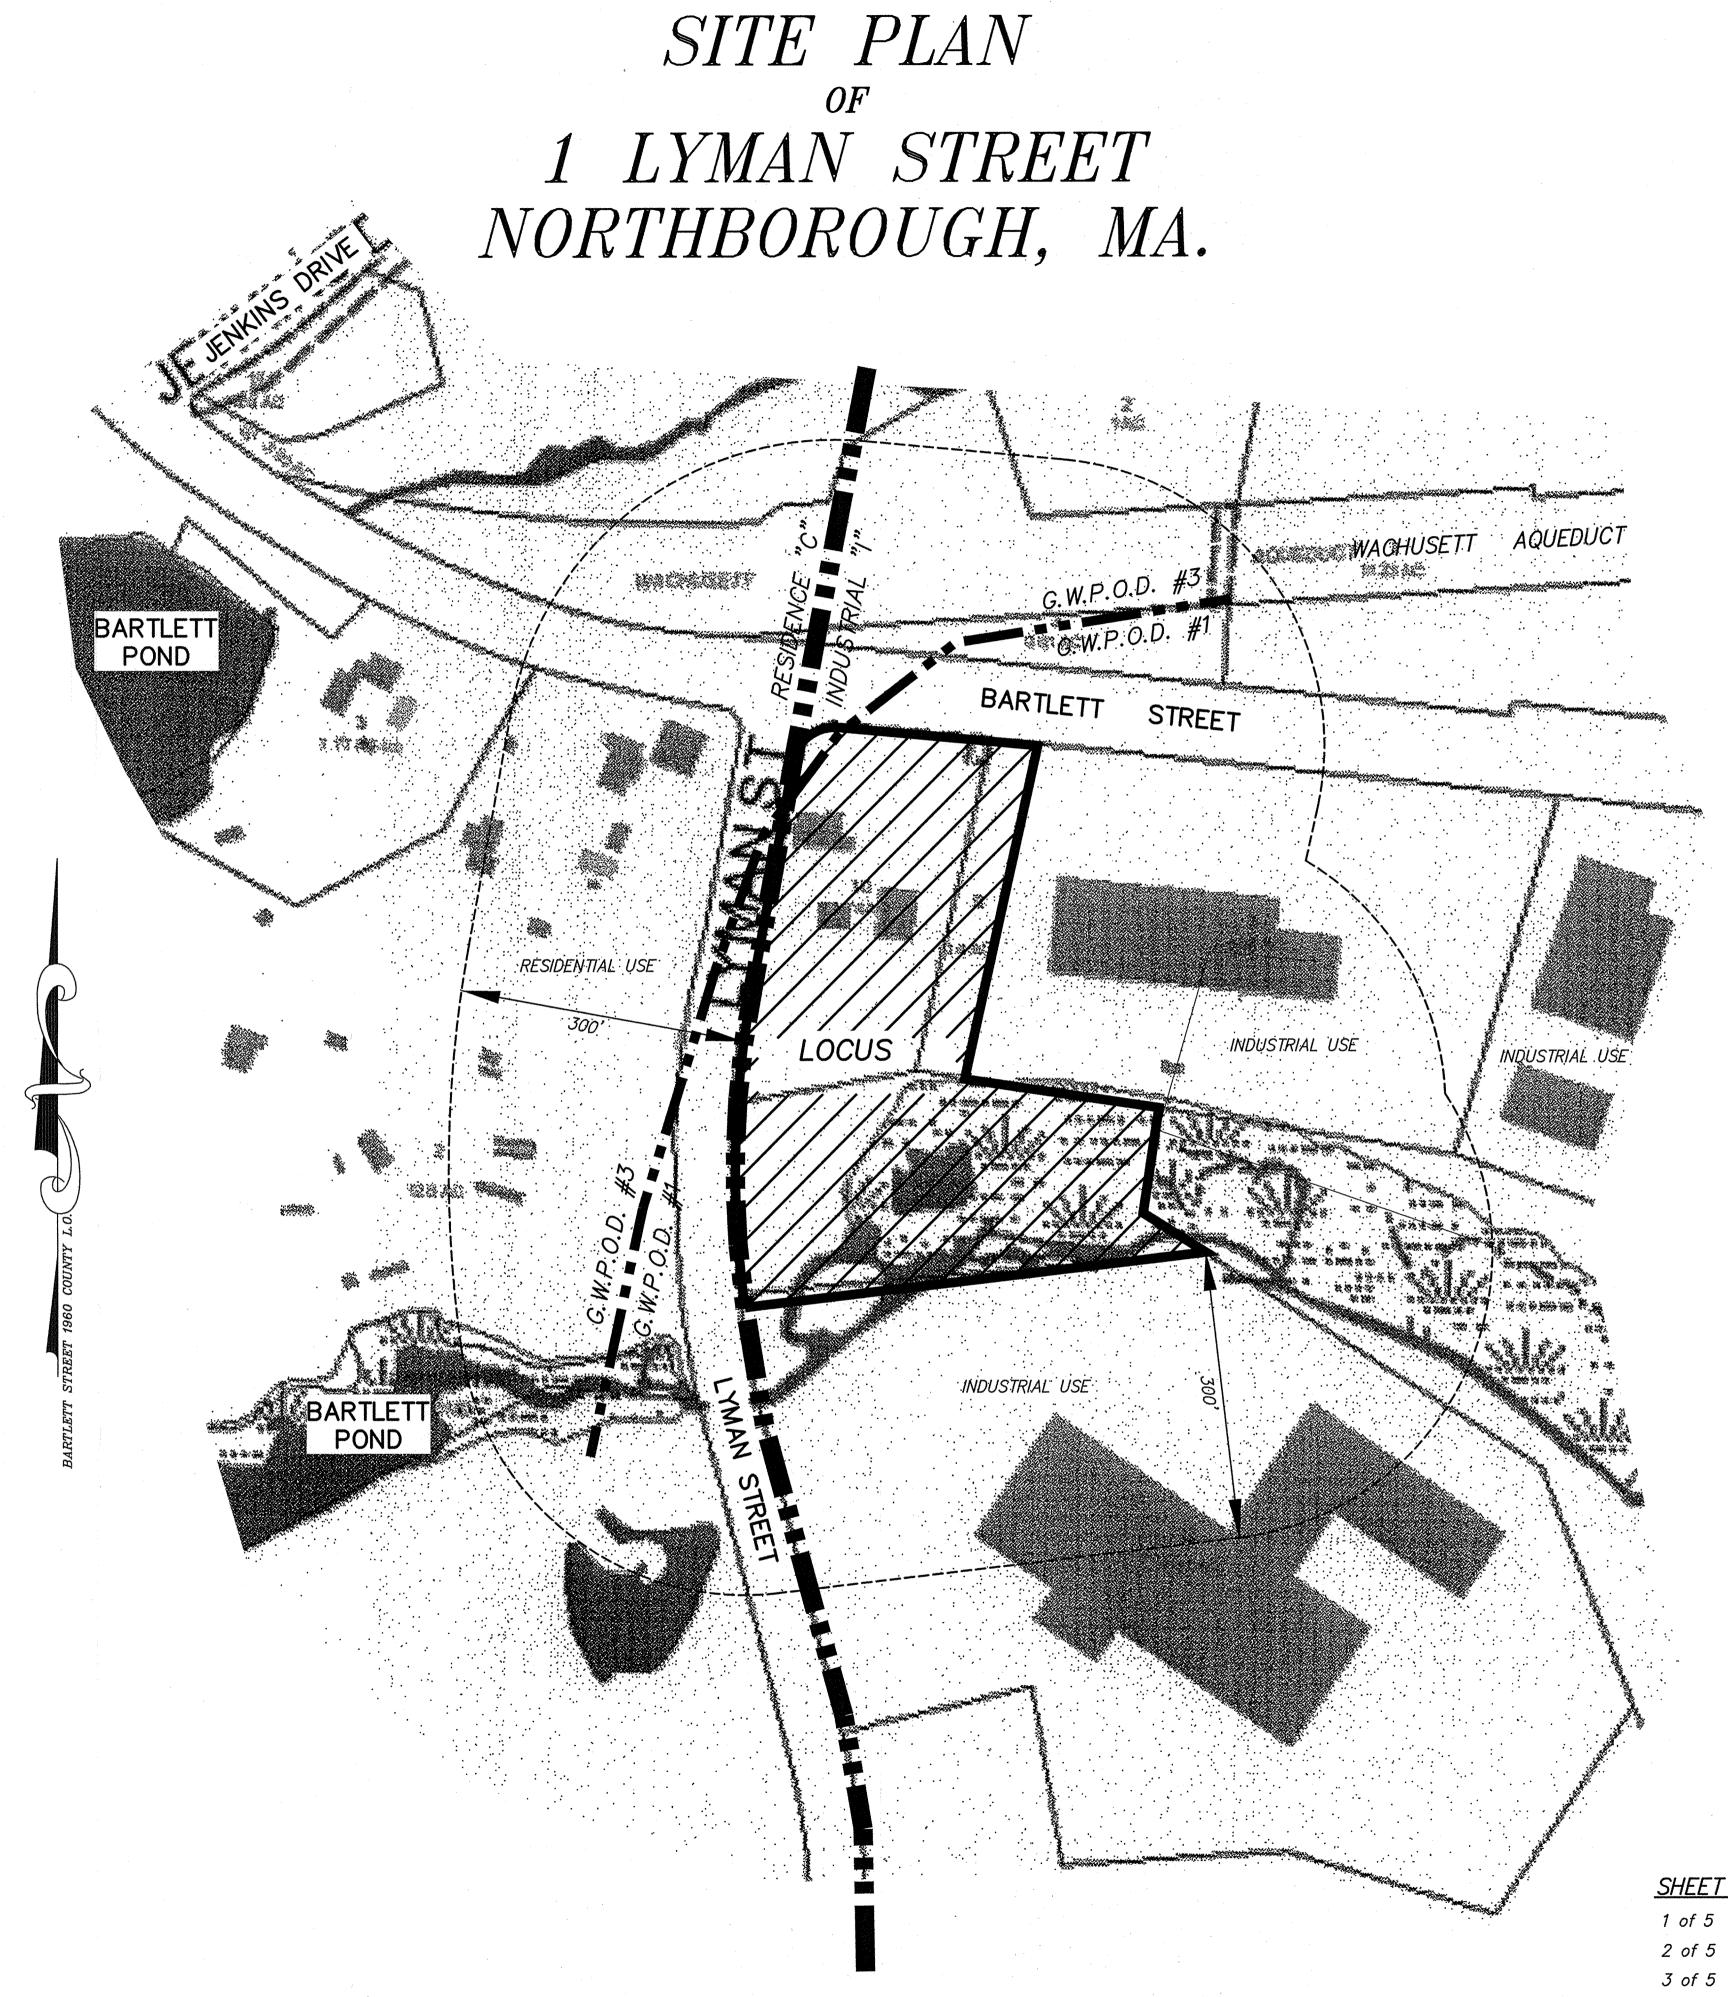

LOCUS MAP:

SCALE: 1"=100'

OPEN SPACE / LANDSCAPE TABULATION:

LOT AREA = 178,809 S.F.

REQUIRED OPEN SPACE = 44,702 S.F. (25%)

PROPOSED OPEN SPACE = 133,689 S.F. (75%)

EXISTING IMPERVIOUS COVER = 7,715 S.F.

PROPOSED IMPERVIOUS COVER = 45,120 S.F.

ZONED: INDUSTRIAL

LOT REQUIREMENTS	REQUIRED	PROPOSED
AREA FRONTAGE	60,000 s.f. 150 FEET	162,959 s.f. 607.20 FEET
FRONT YARD	40 FEET	50.9 FEET
SIDE YARD REAR YARD	20 FEET 25 FEET	332.7 FEET 60.4 FEET
$MAXIMUM\ LOT\ COVERAGE = 50\%$ 12.4%		
MINIMUM OPEN SPACE =	72.3%	

GROUNDWATER OVERLAY PROTECTION DISTRICT -1

PARKING REQUIREMENTS:

INDUSTRIAL USES:

OFFICE: 1 SPACE / 300 S.F. MINIMUM

1 SPACE / 200 S.F. MAXIMUM

WAREHOUSE:

1 SPACE / 1500 S.F. MINIMUM 1 SPACE / 1000 S.F. MAXIMUM

PROPOSED USES:

6,000 S.F. OFFICE 17,000 S.F. WAREHOUSE

MINIMUM SPACES REQUIRED = 32 MAXIMUM SPACES ALLOWED = 47 TOTAL SPACES PROPOSED = 43

OWNER:

IAN A. GOW
146 BOSTON ROAD
SOUTHBOROUGH, MA. 01772

THE BLACK STONE TRUST
IAN A. GOW, Trustee
146 BOSTON ROAD
SOUTHBOROUGH, MA. 01772

ASSESSORS MAP 66, PARCEL 9,10,11

PREPARED FOR:

JEFF JIANG
CABLE MATTERS, INC.

153 NORTHBORO ROAD

SOUTHBOROUGH, MA. 01772

CONNORSTONE ENGINEERING INC.

CIVIL ENGINEERS AND LAND SURVEYORS

10 SOUTHWEST CUTOFF, SUITE 7

NORTHBOROUGH, MASSACHUSETTS 01532

PHONE: 508–393–9727 FAX: 508–393–5242

PROPOSED SITE PLAN

OF

1 LYMAN STREET IN

NORTHBOROUGH, MA

1/16/2021	BUILDING EDITS	
3/24/2021	DESIGN REVIEW/BLDG. EDITS	
2/16/2021	DESIGN REVIEW EDITS	
3/20/2020	DESIGN EDITS	
REVISED:	DESCRIPTION:	
DRAWN BY: REM		CHECK BY: VC
DATE: FEBRUARY 19, 2020		
SCALE: 1"	<i>'=30'</i>	SHEET 1 OF 5

SHEET INDEX

f 5 COVER SHEET

of 5 EXISTING CONDITIONS PLAN

5 PROPOSED SITE PLAN

of 5 PROPOSED EROSION CONTROL PLAN

5 CONSTRUCTION DETAILS

GRAPHIC SCALE: 1"=200'
0 100 200 300 400 600 800 1000 FEET

